



Appendix 6-6


Biodiversity Chapter Figures

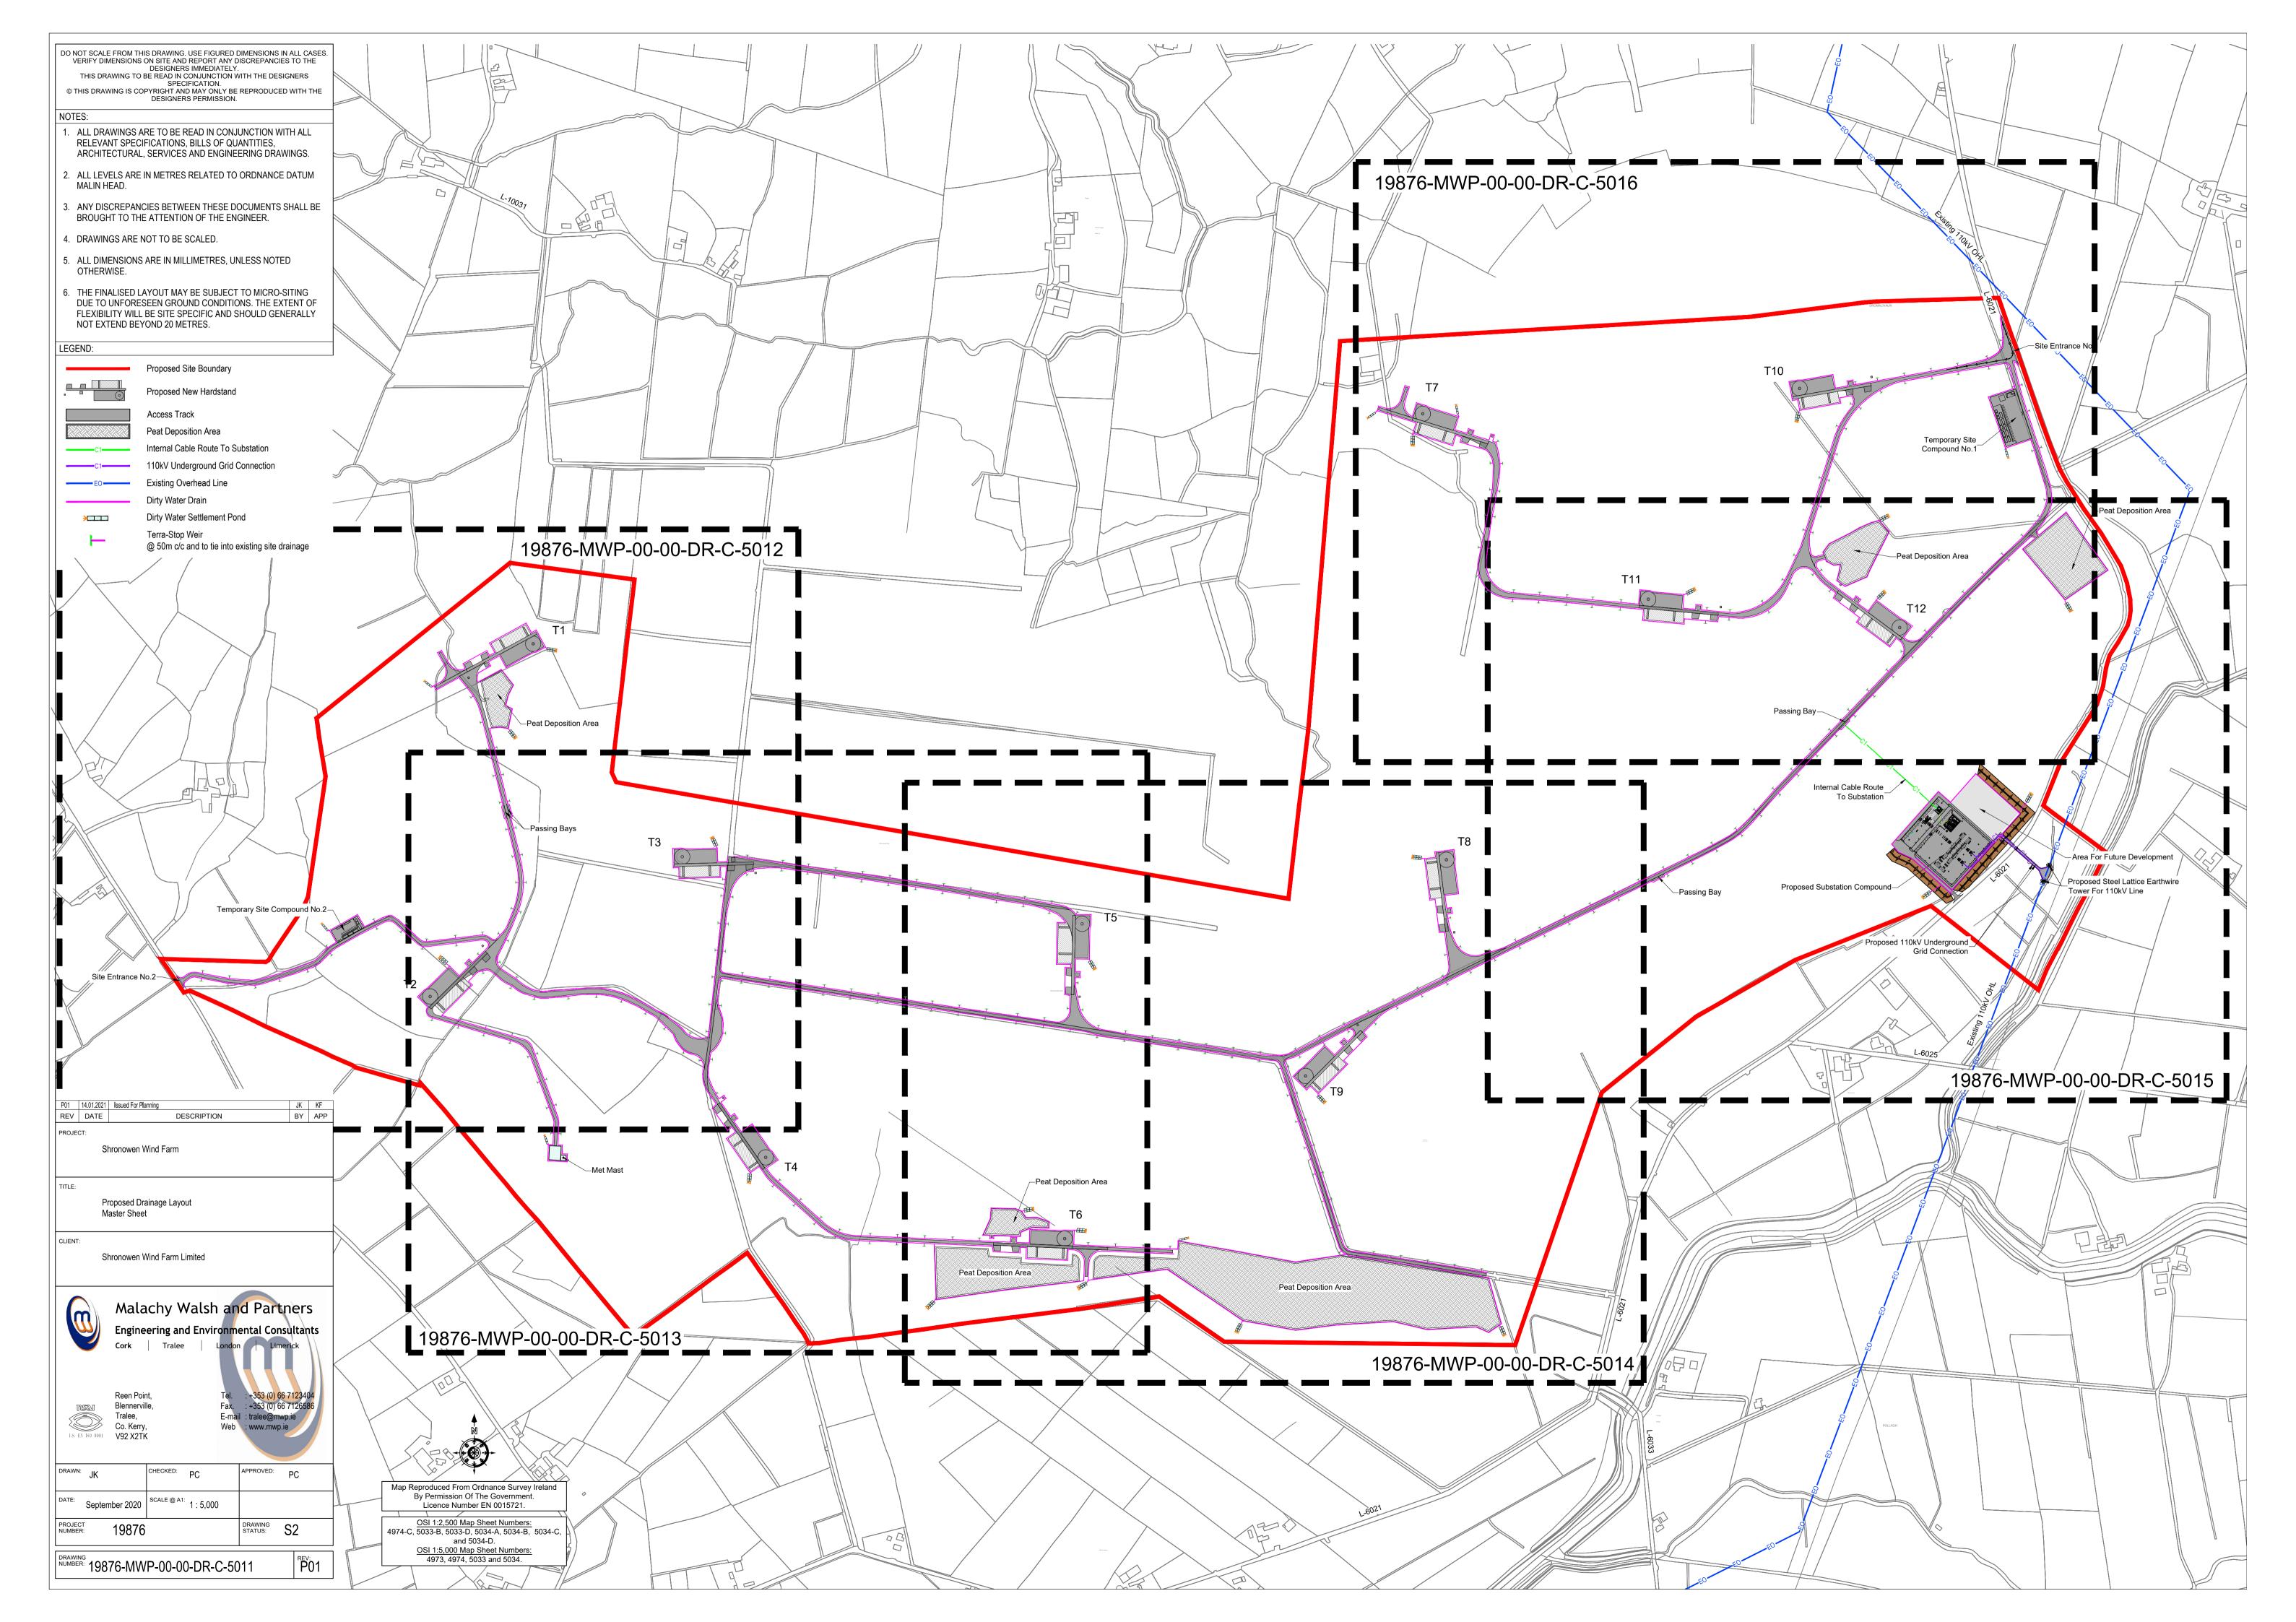


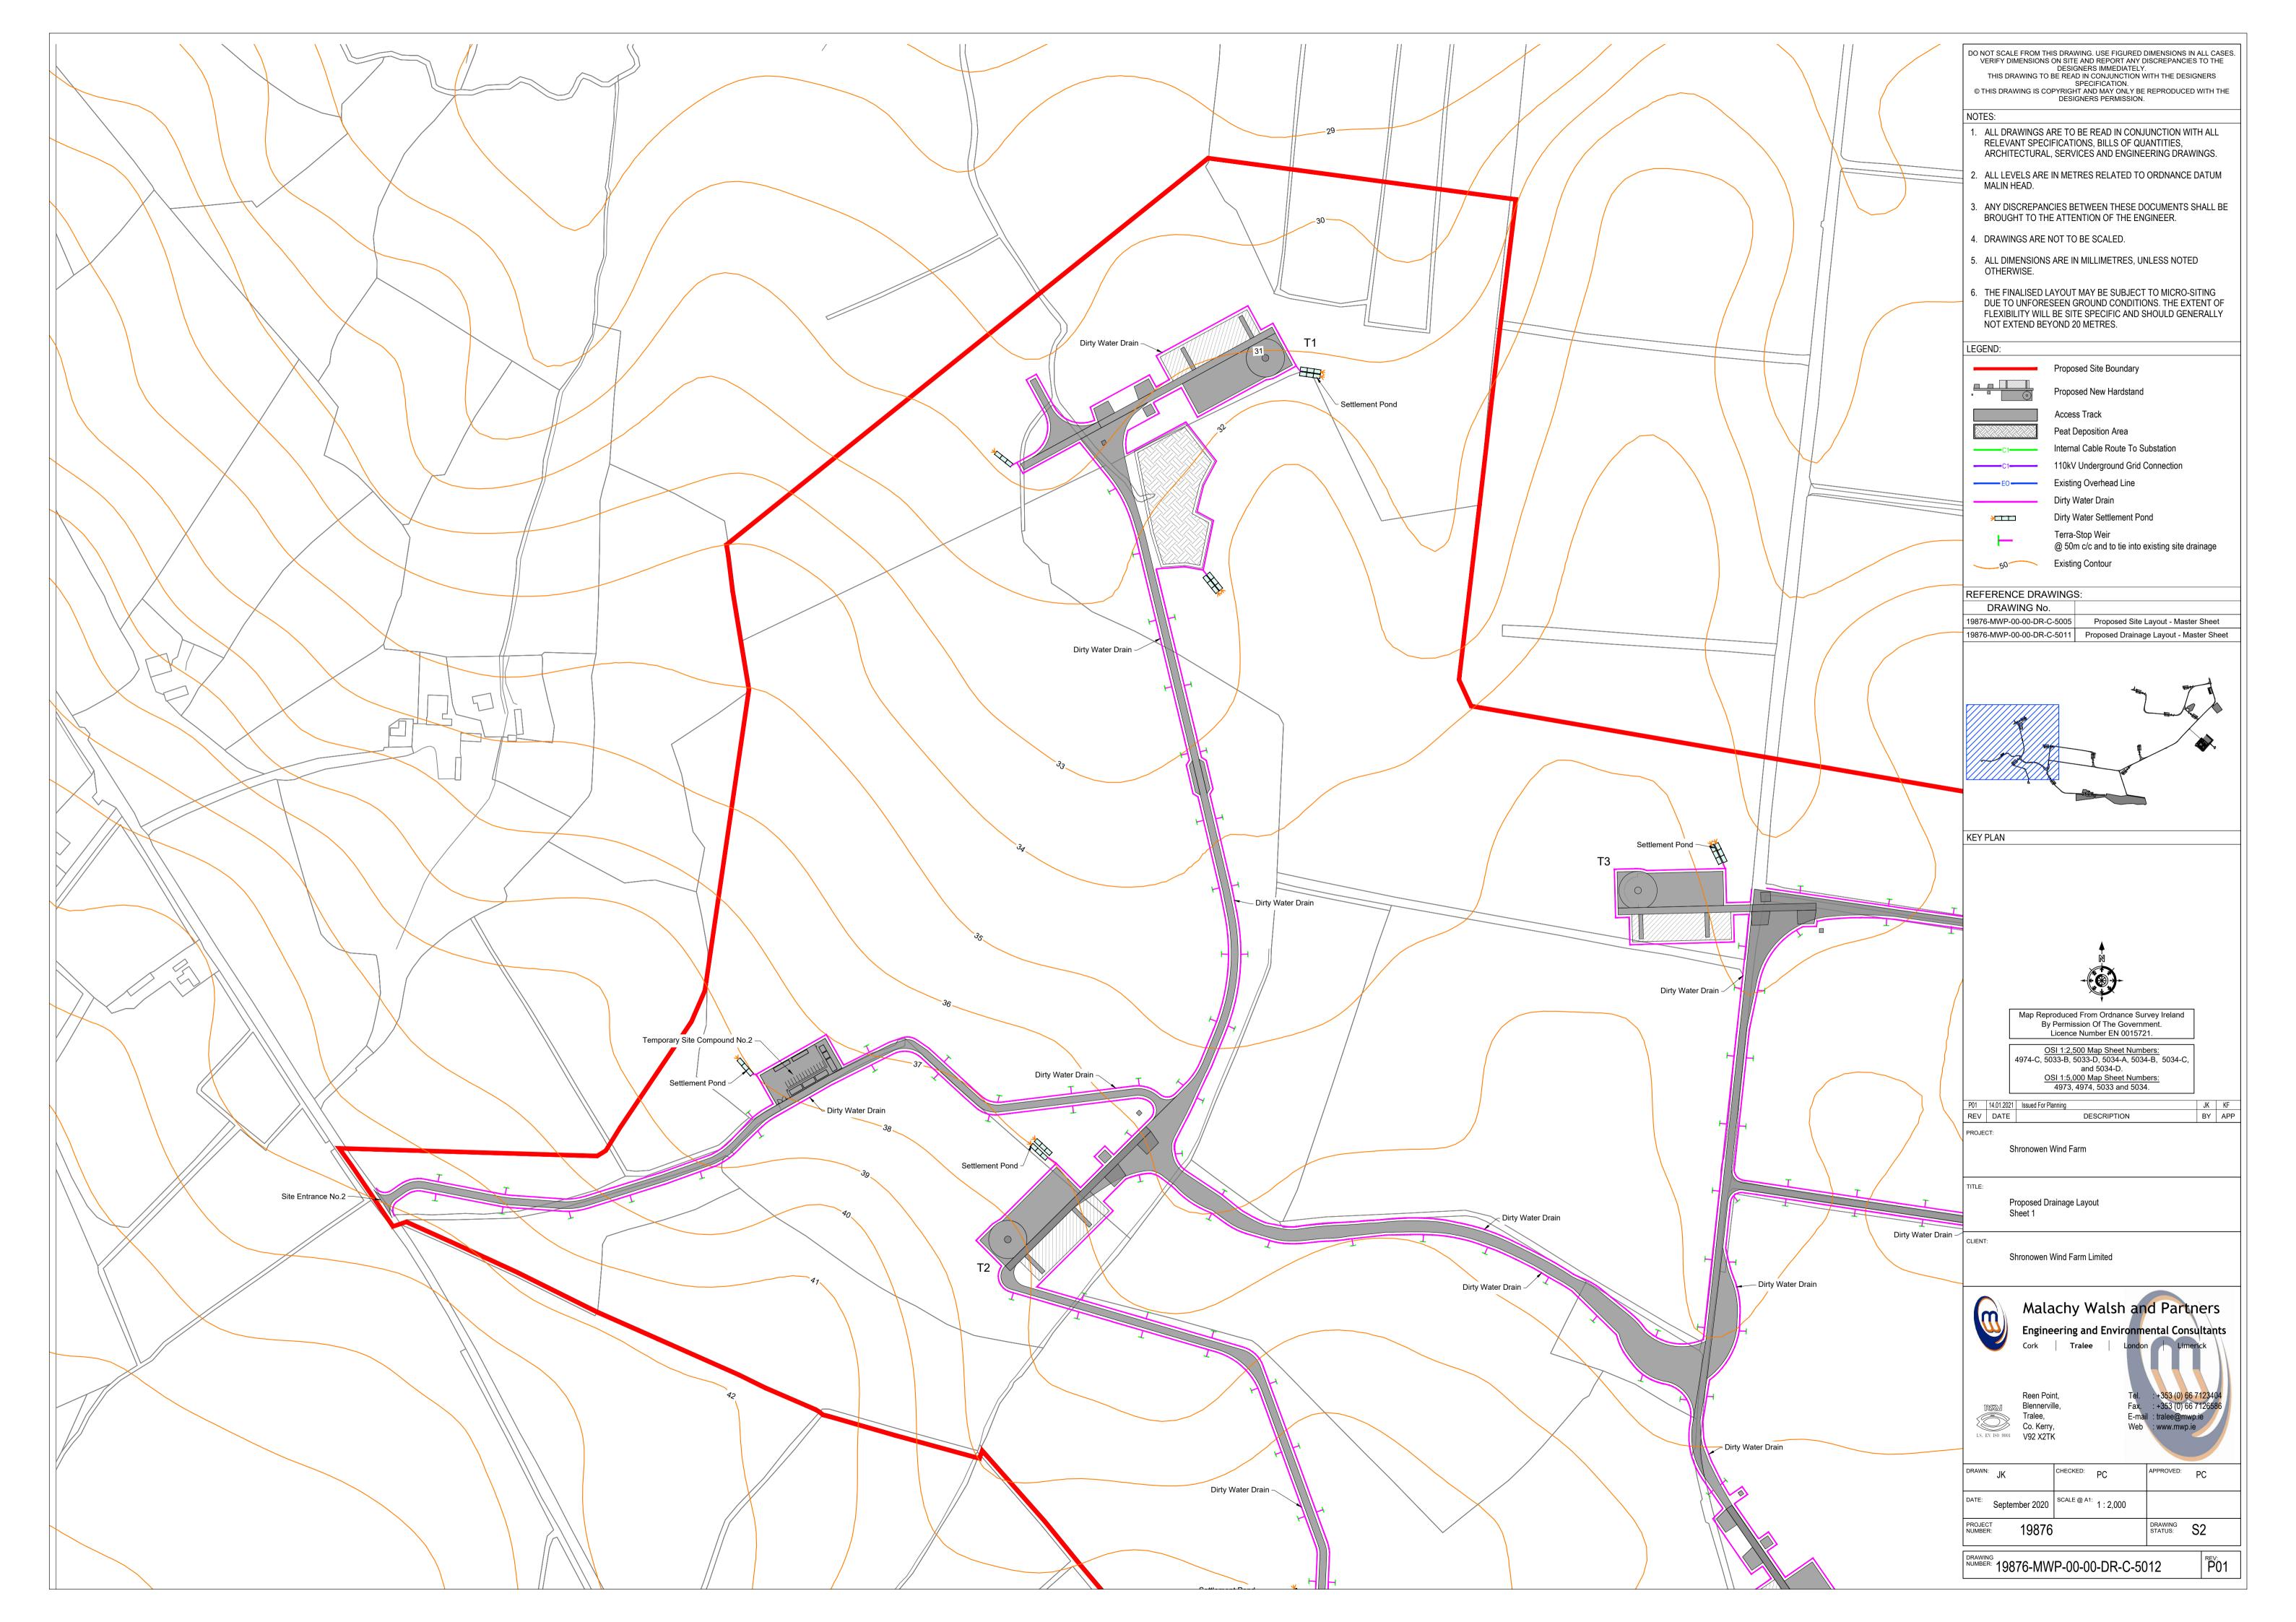


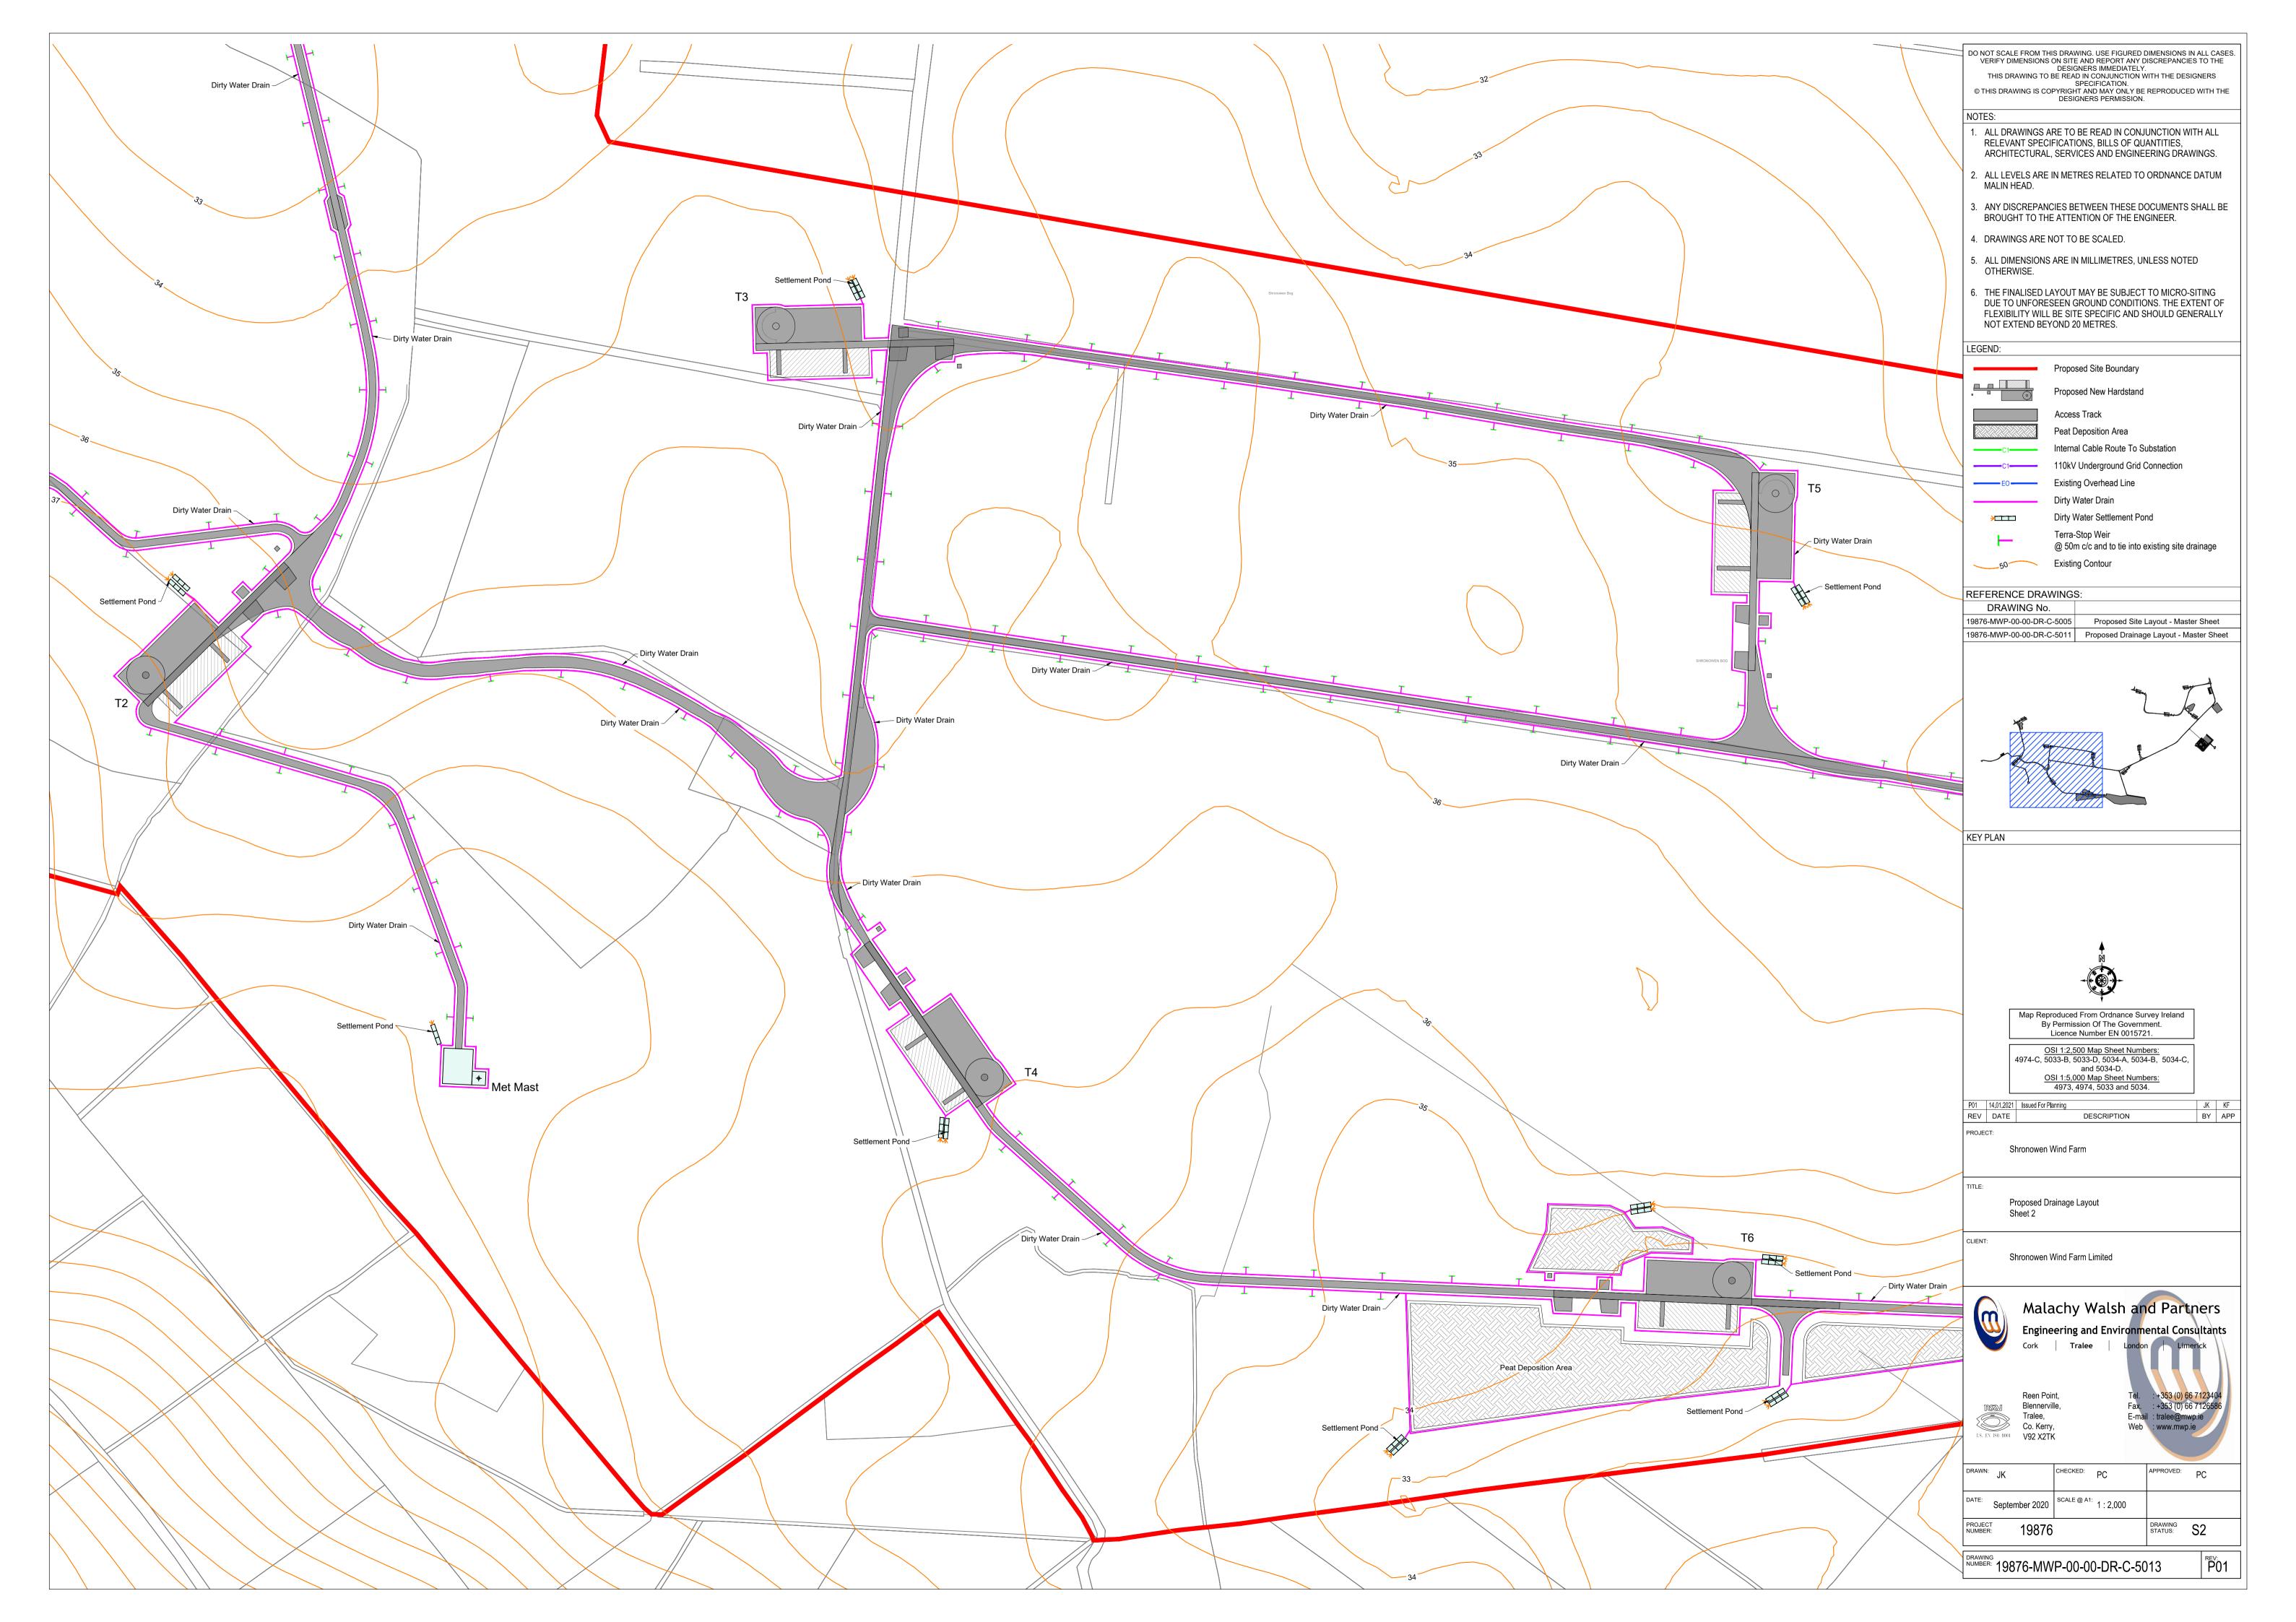


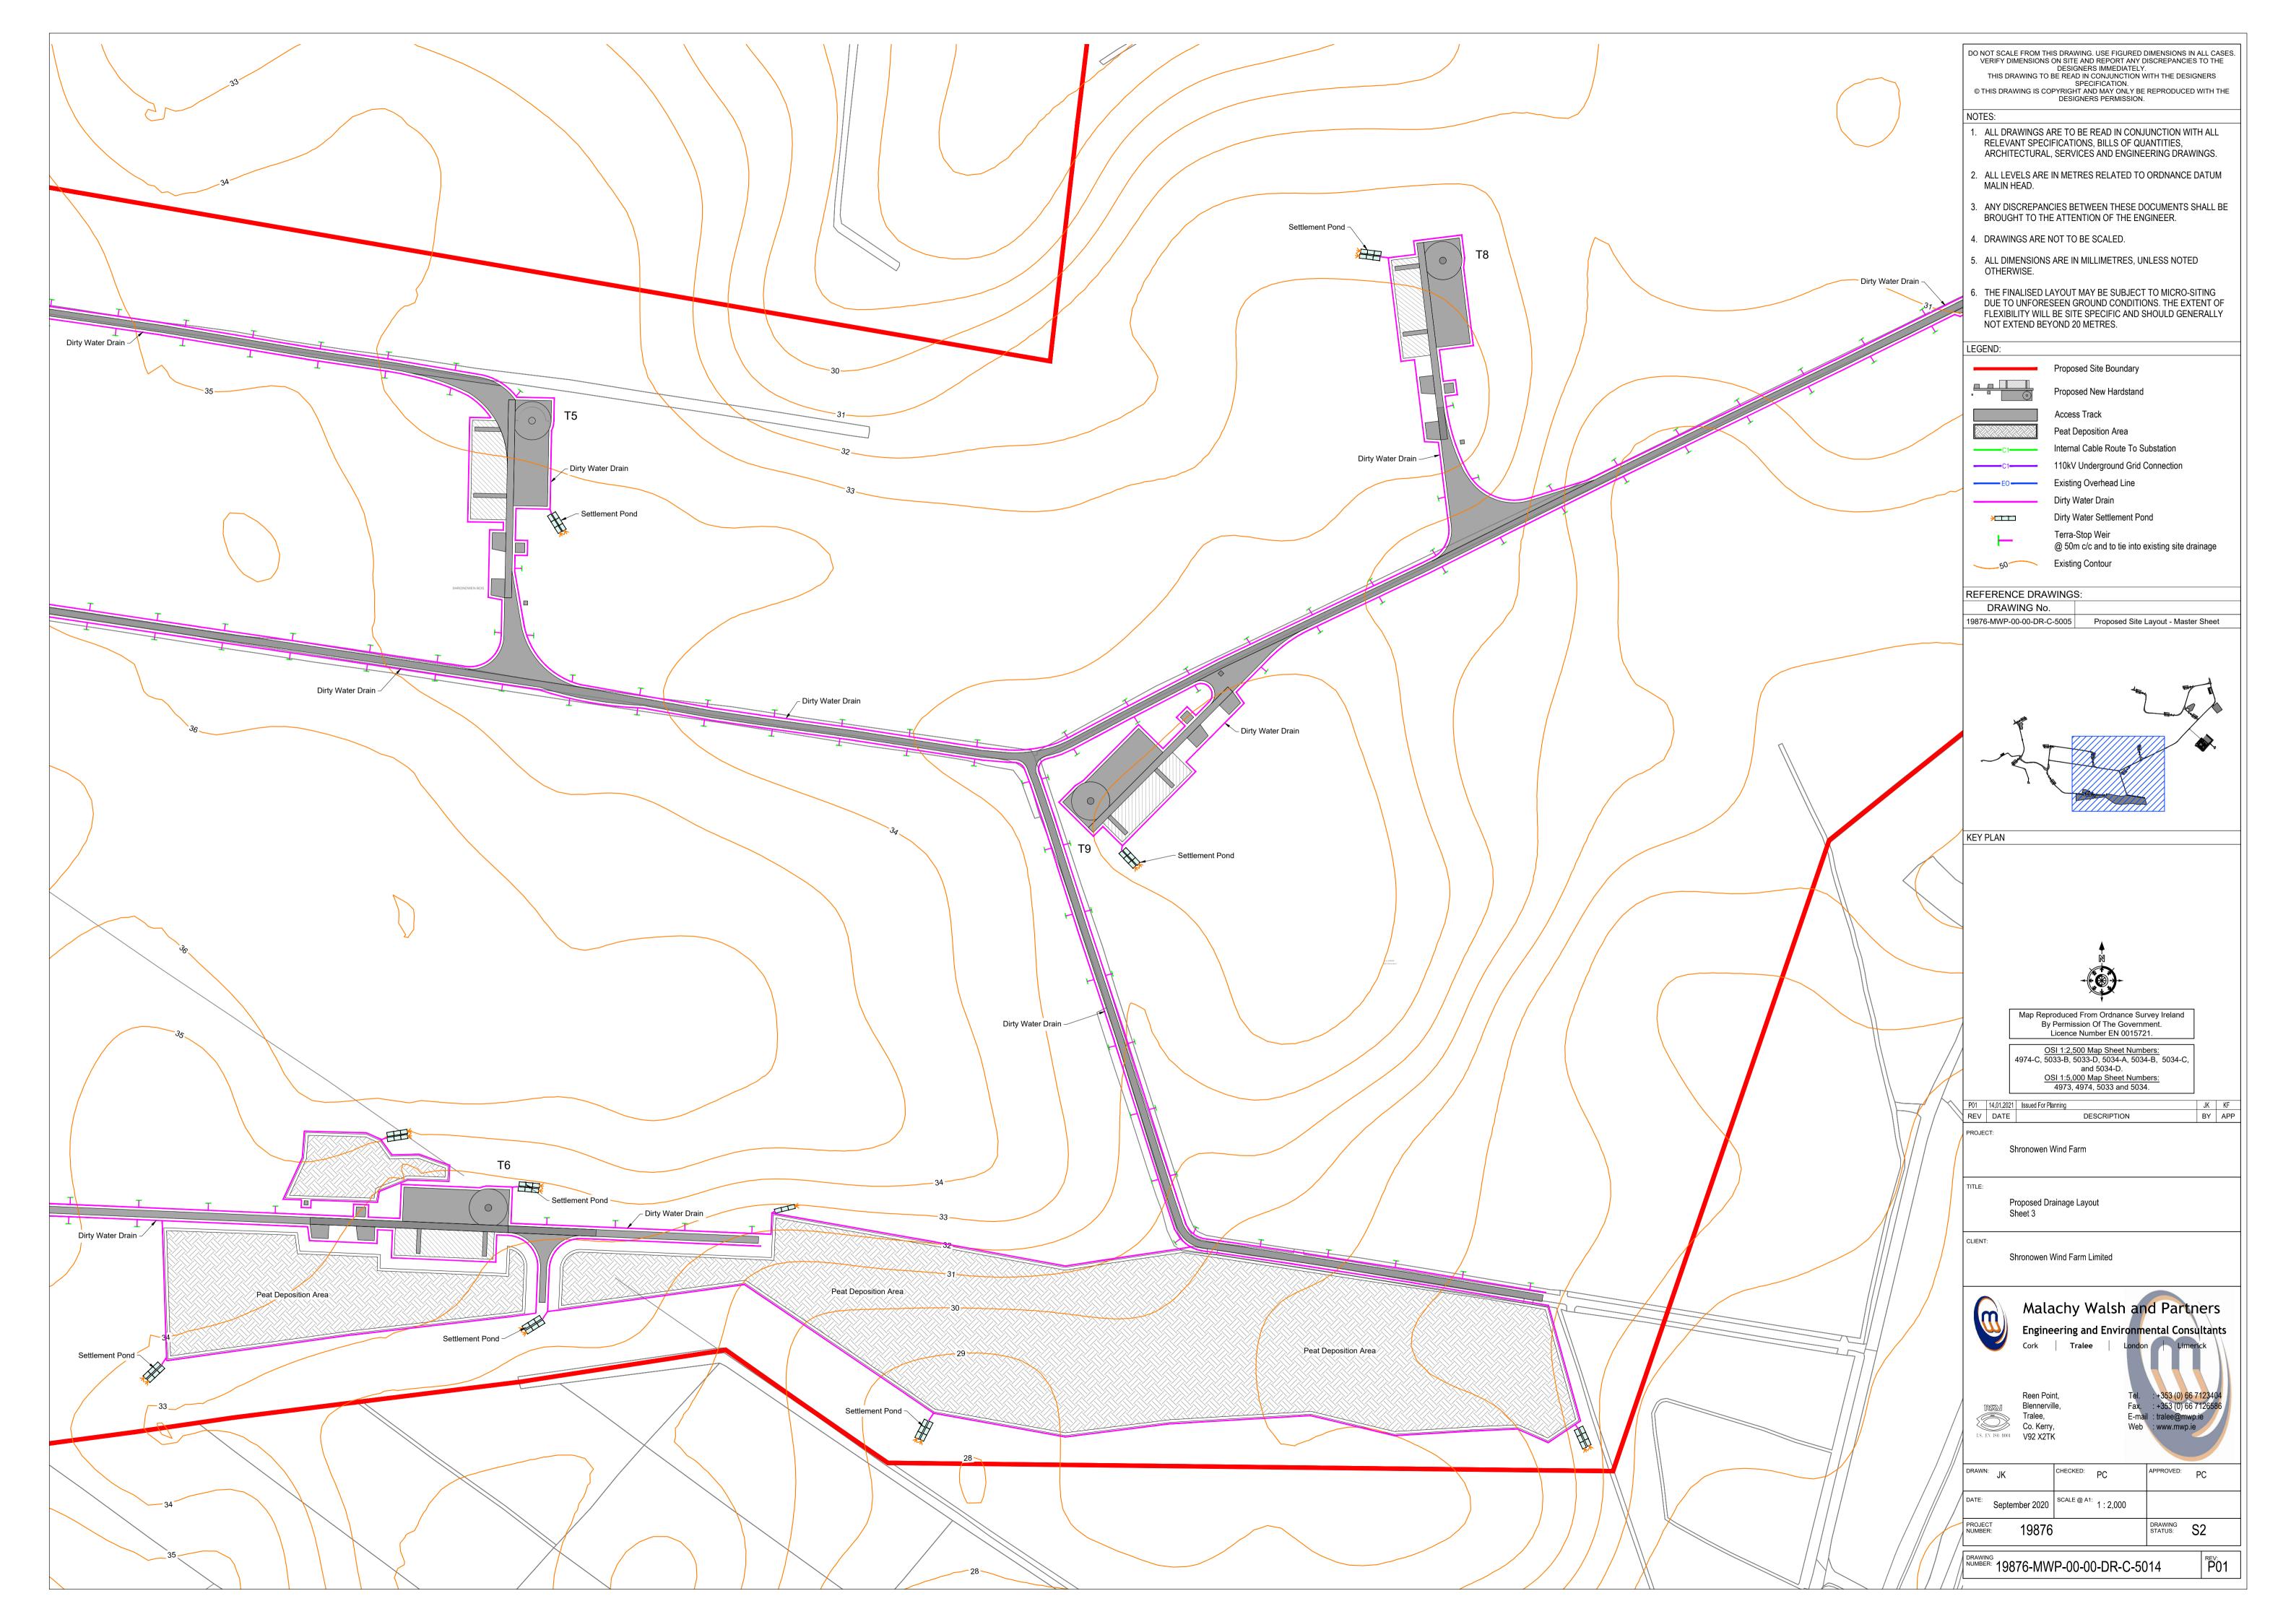

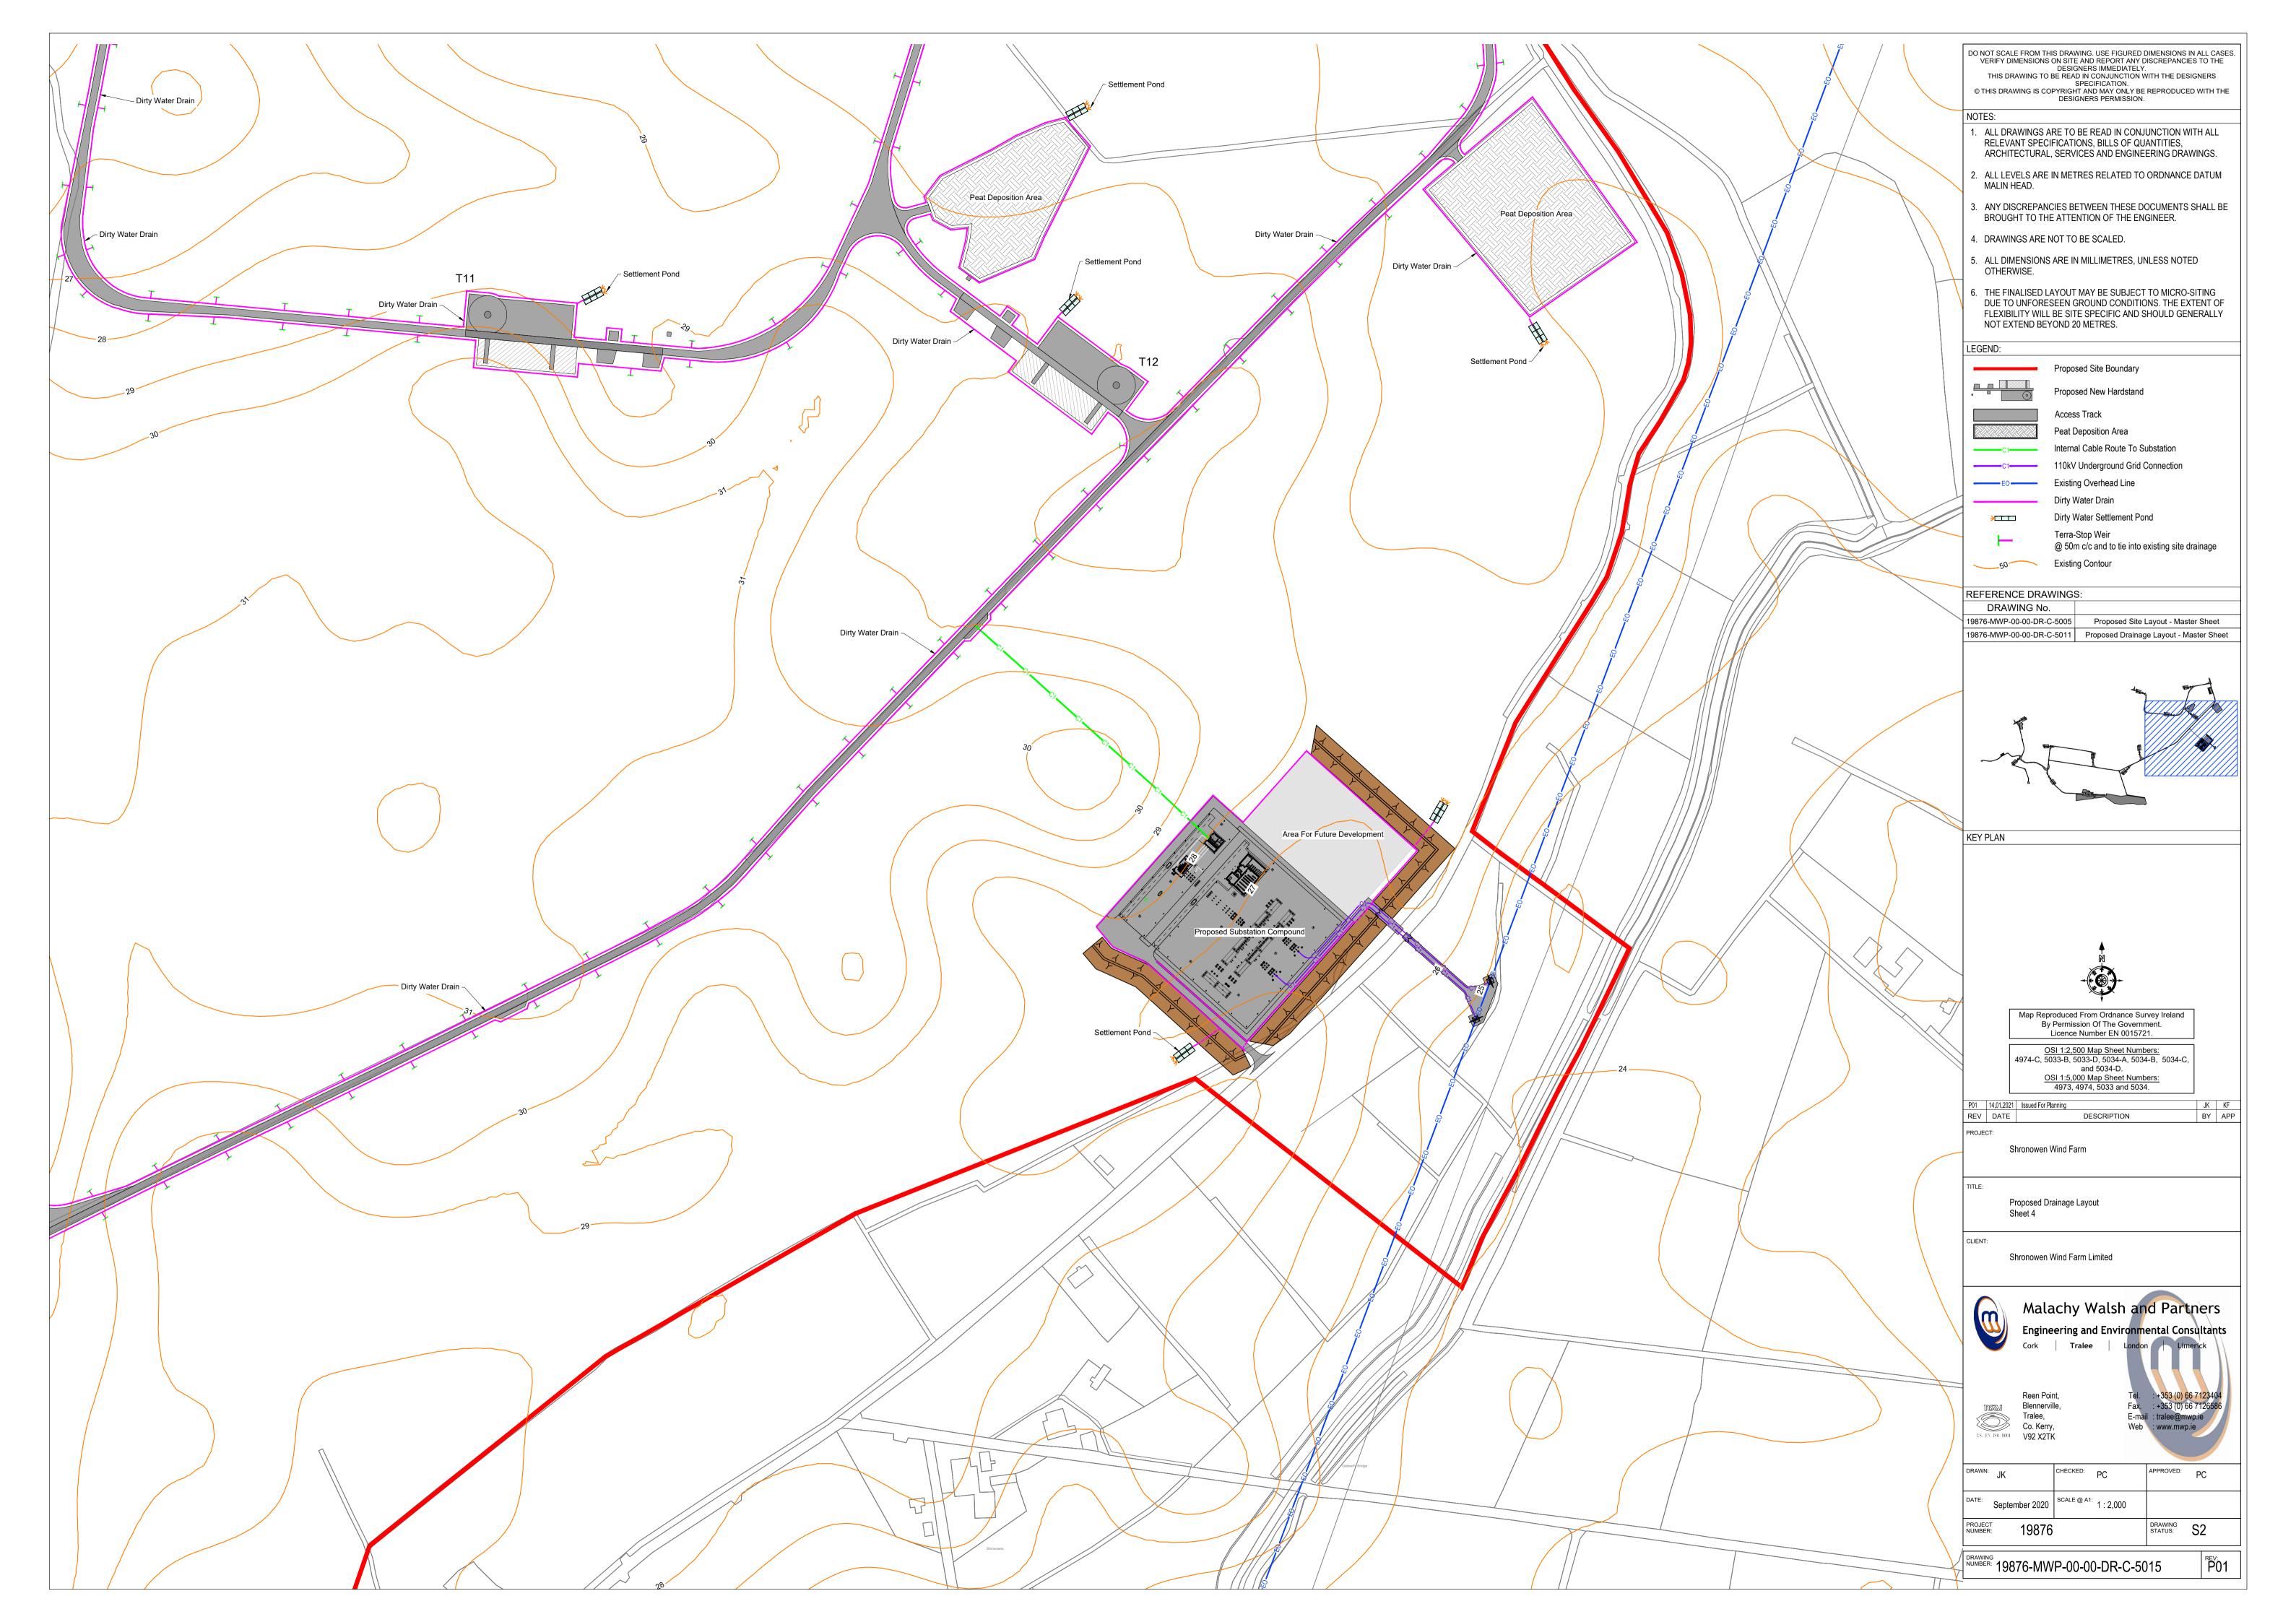


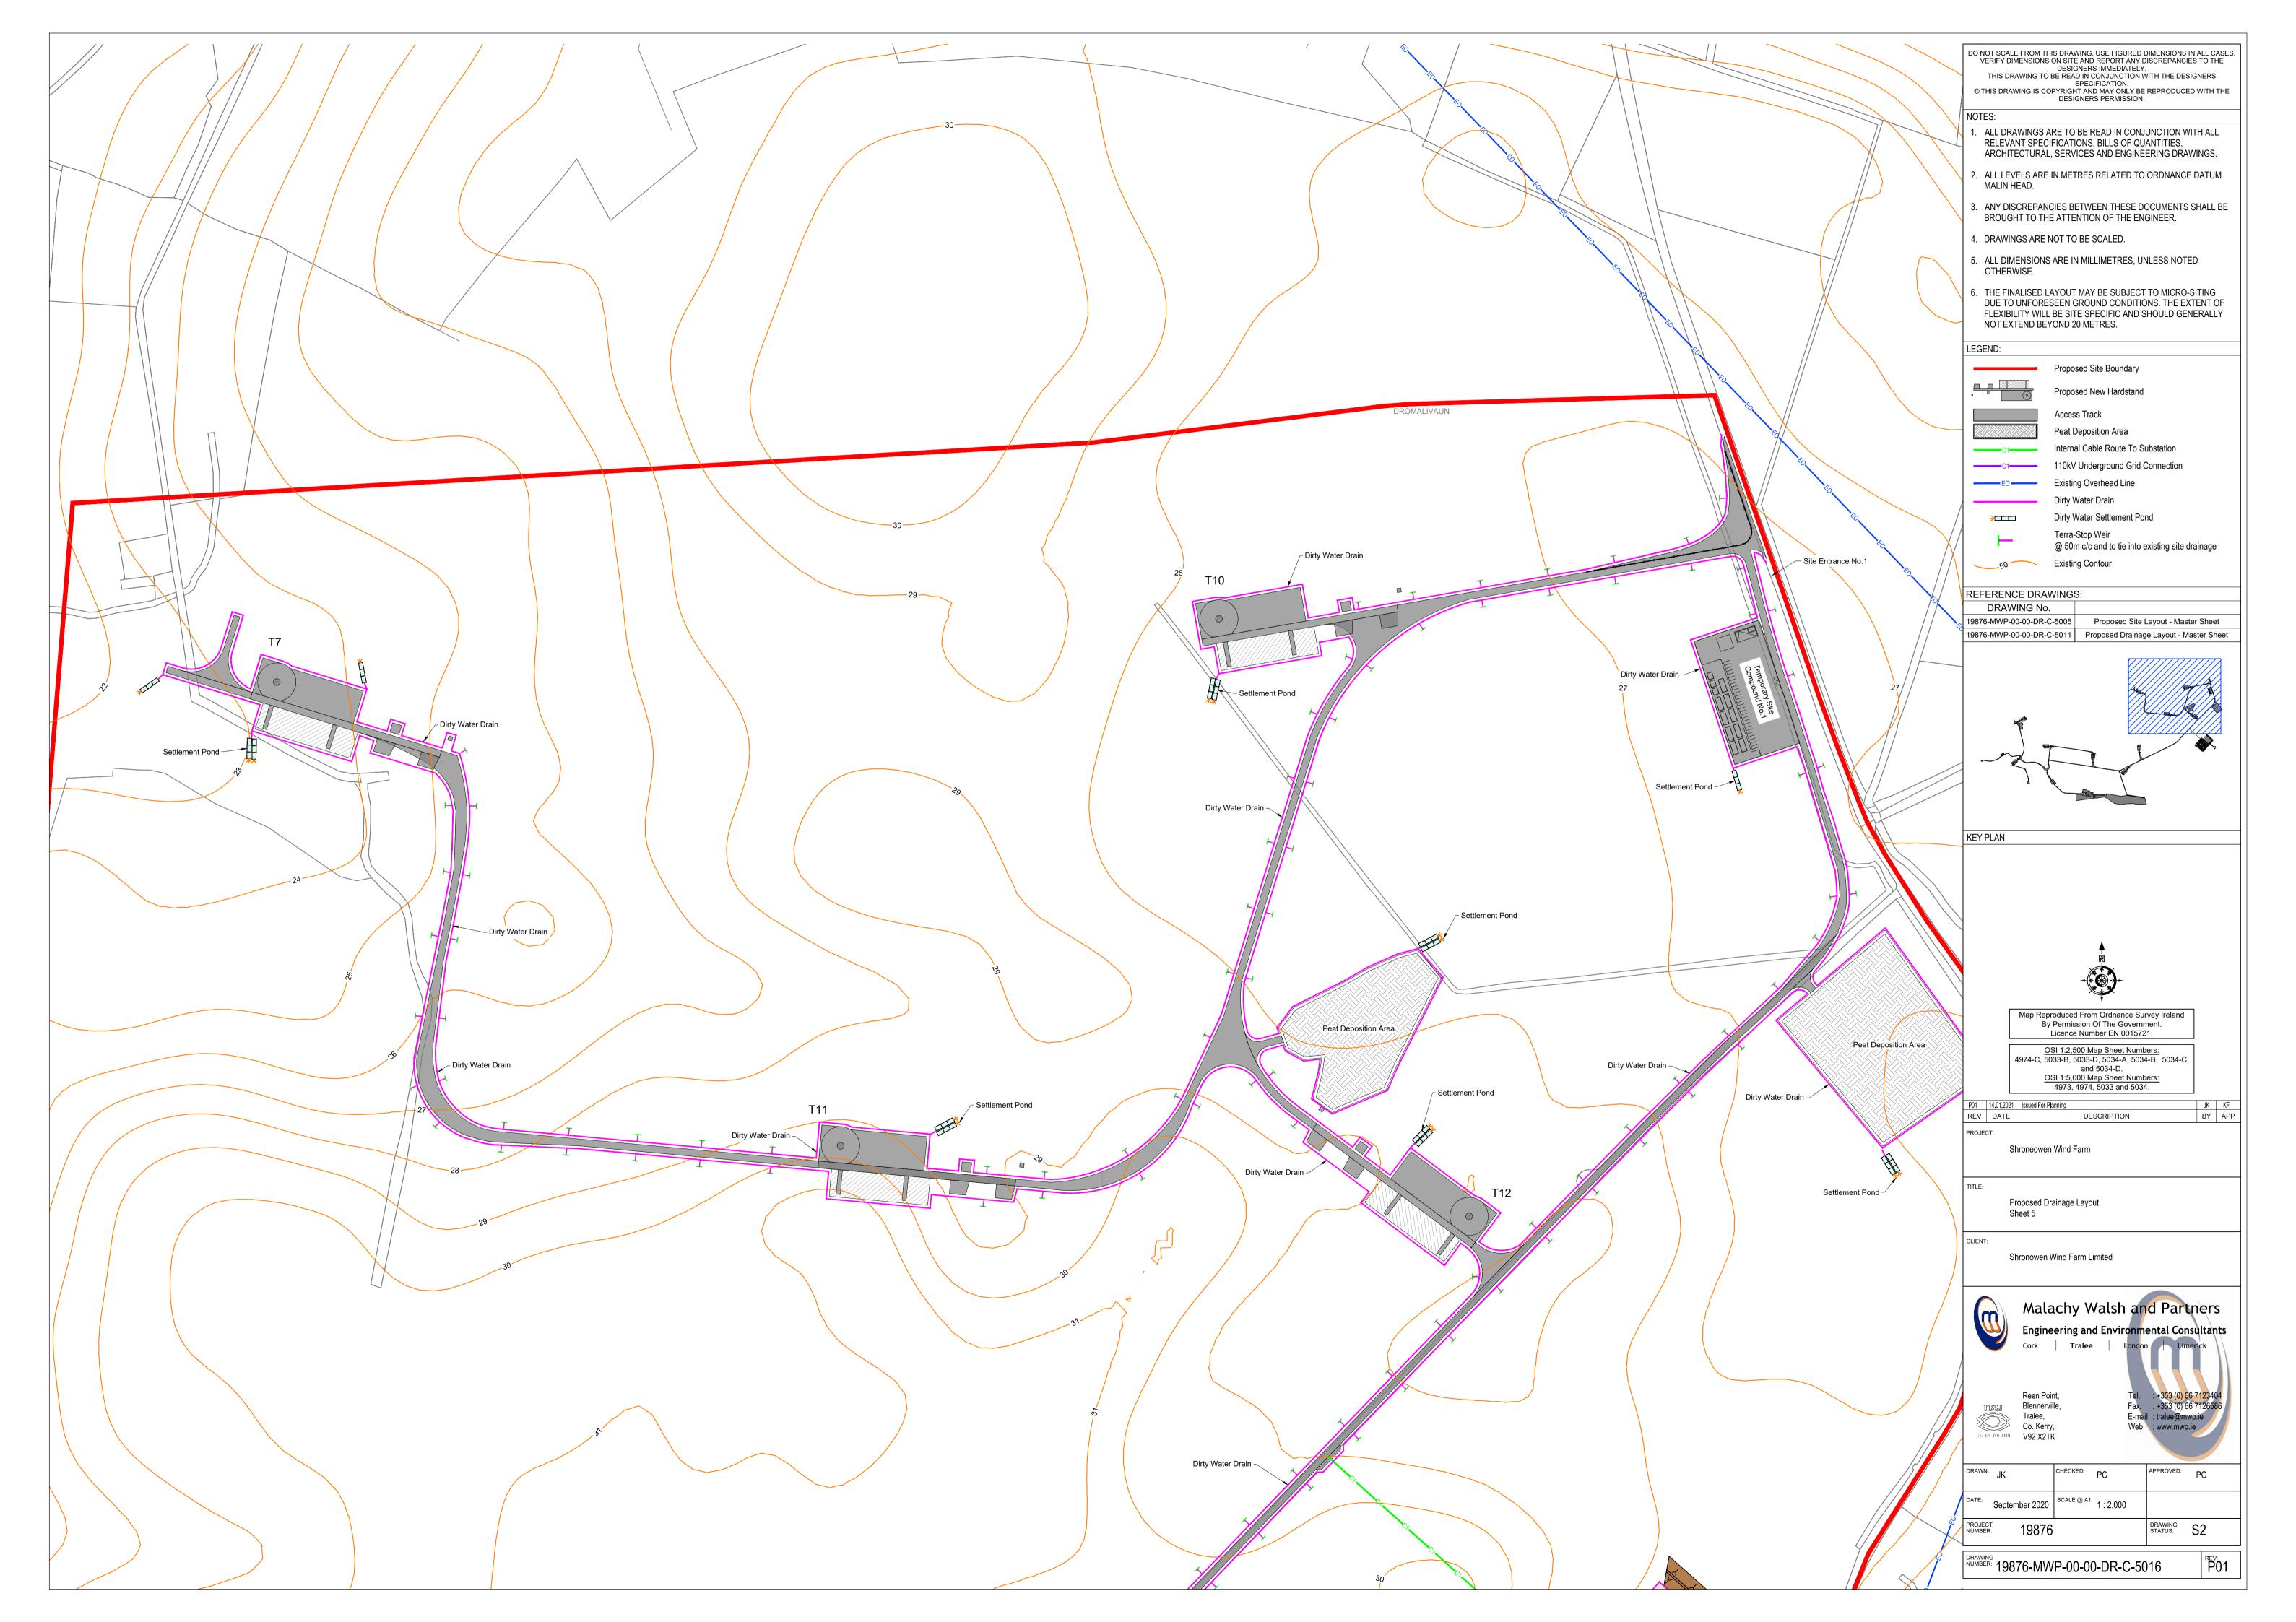

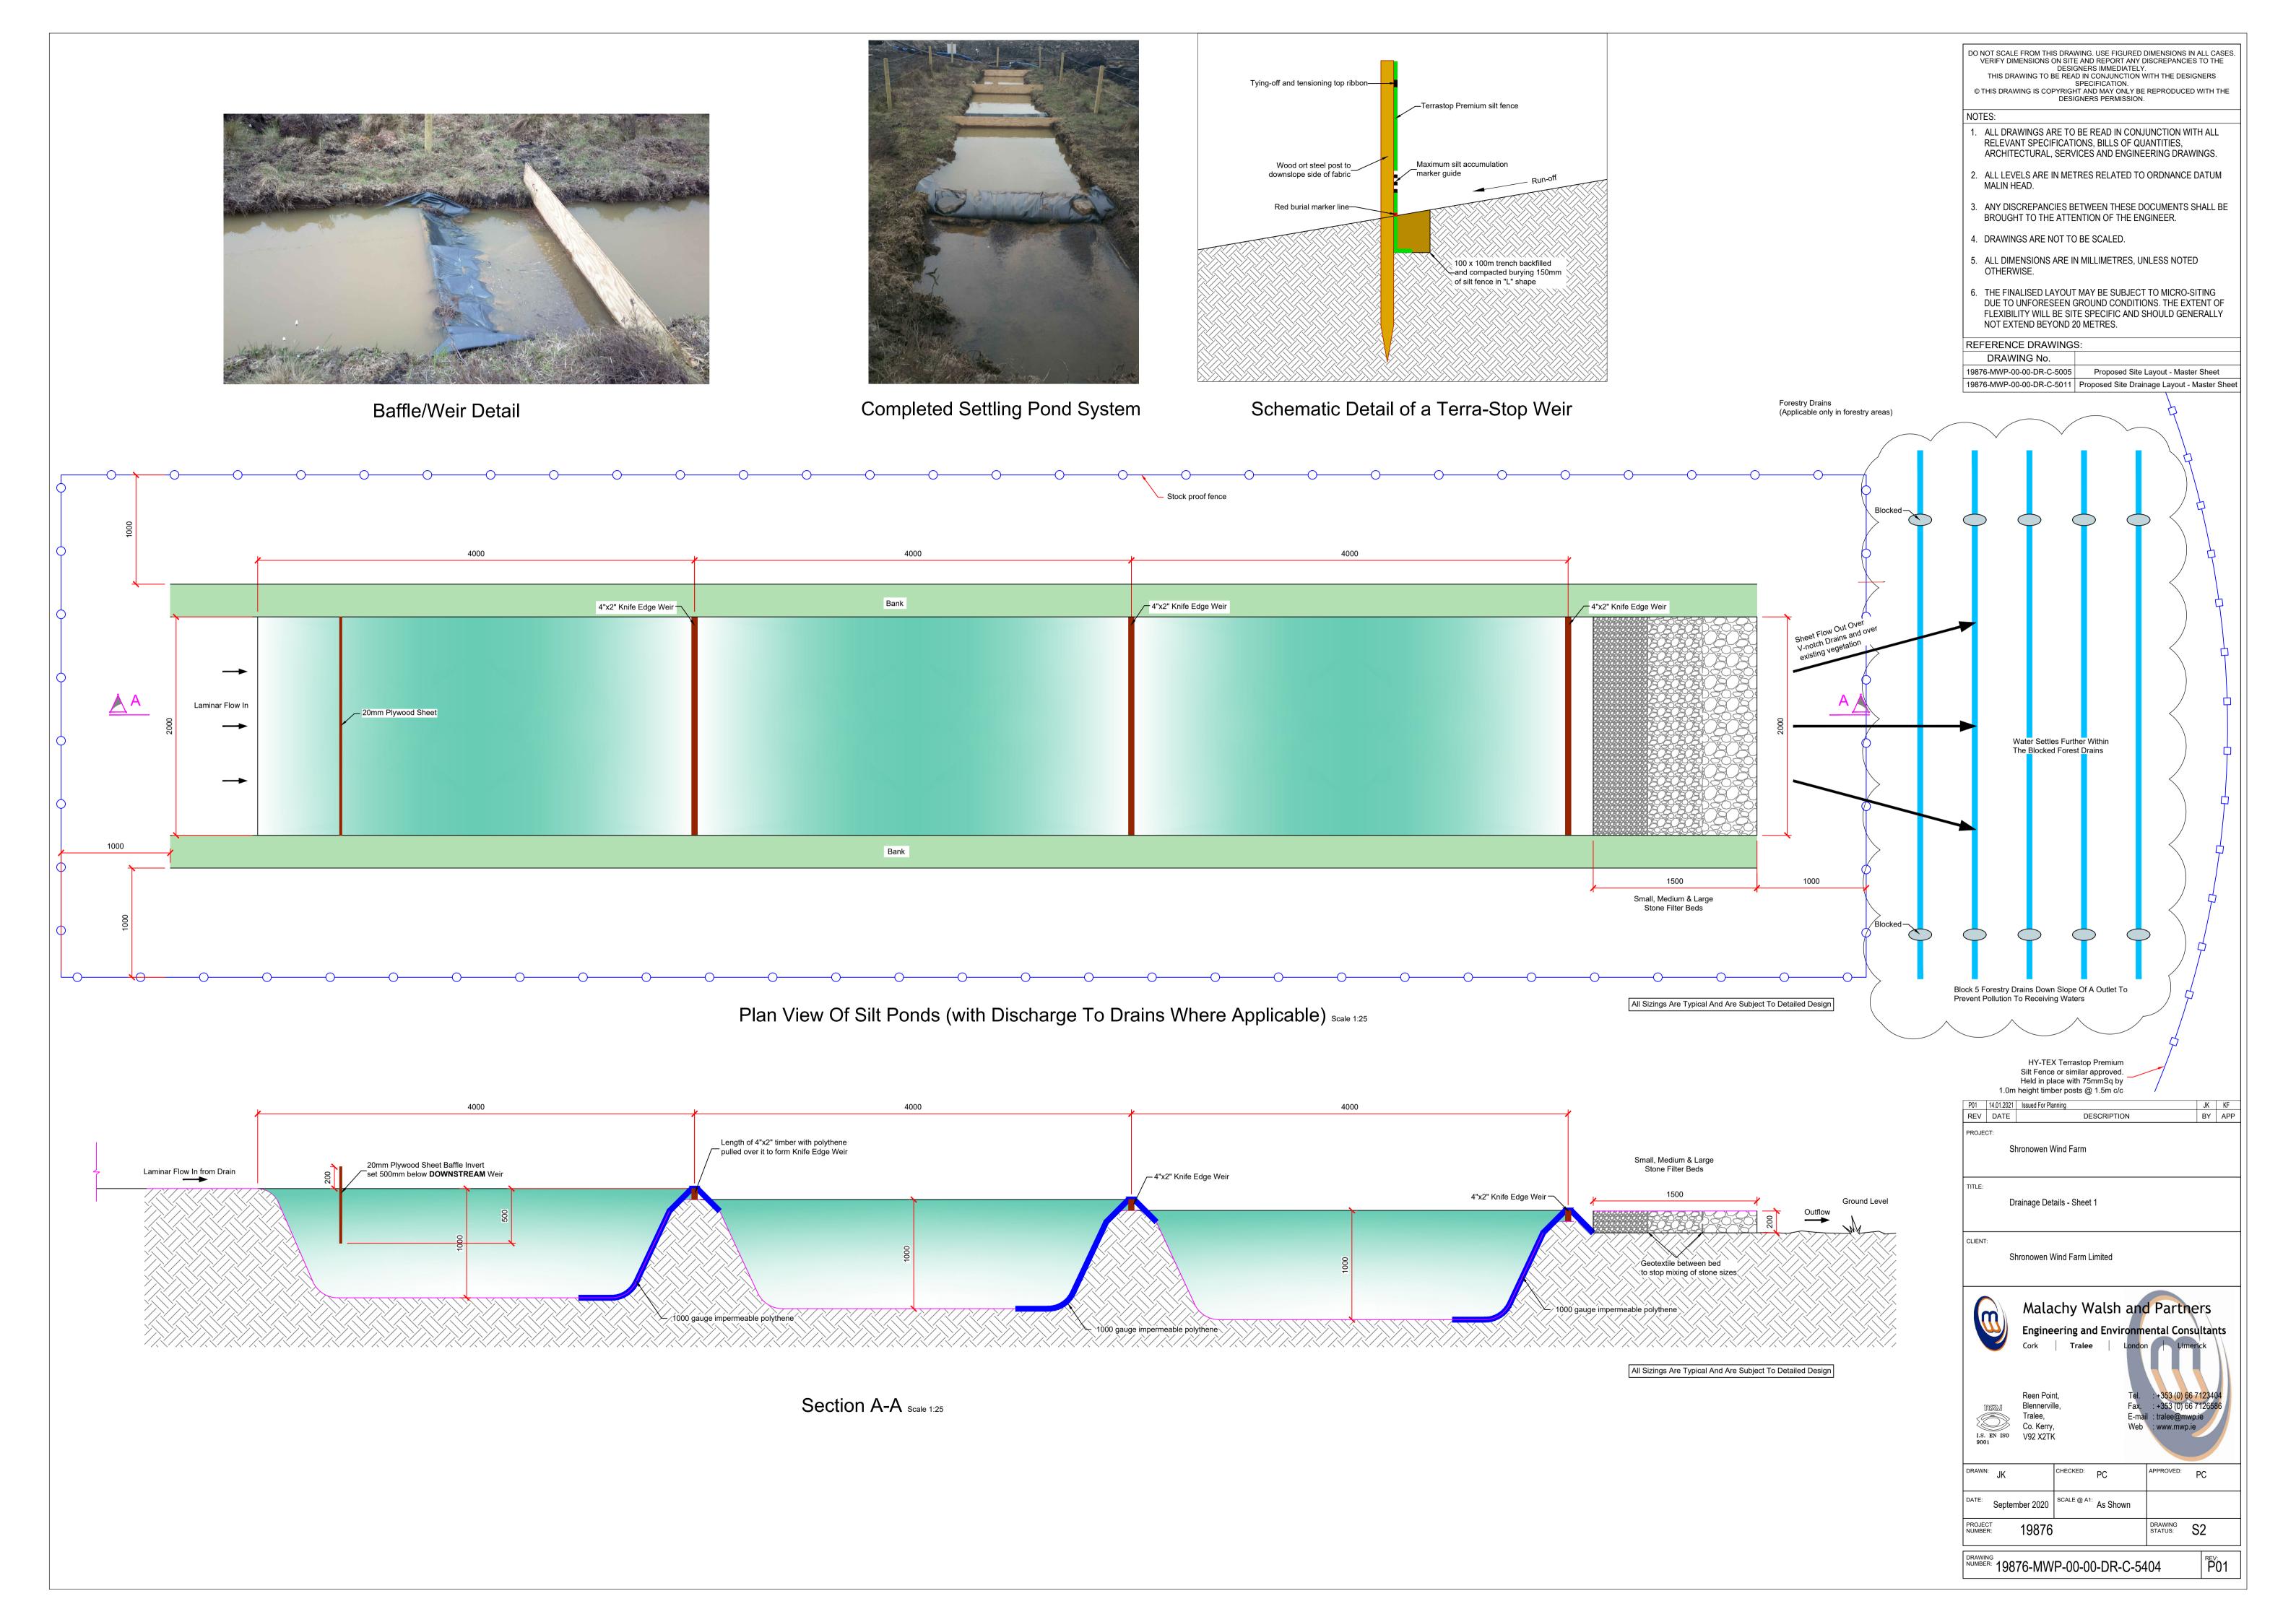


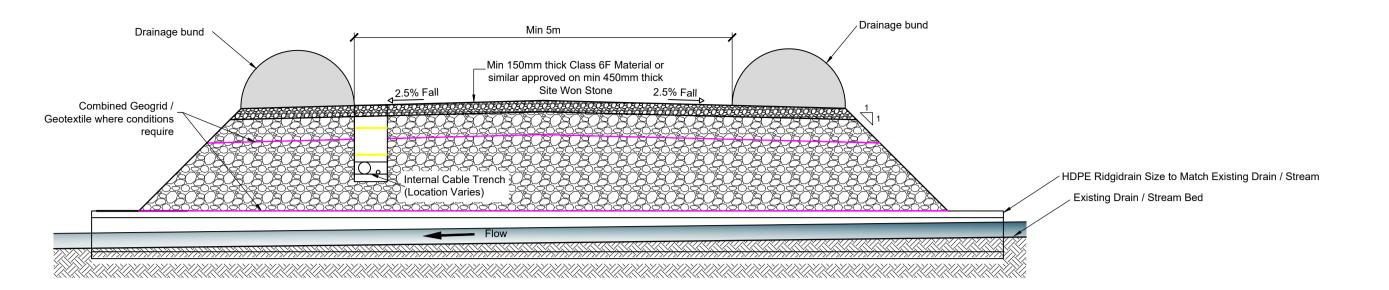

Typical Land Drain / Stream Crossing Detail - Longitudinal Section Scale 1:50

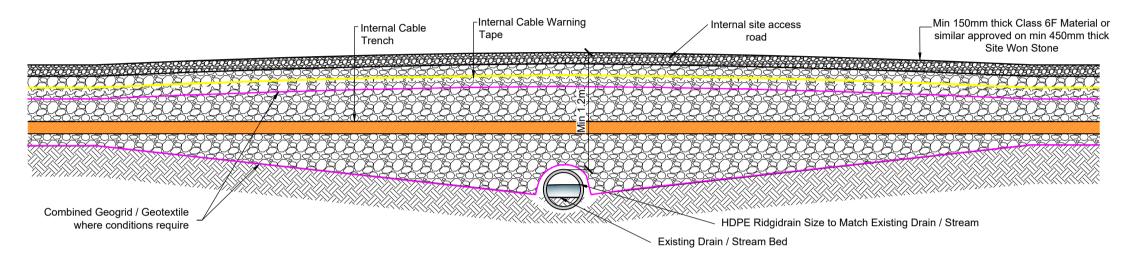

Typical Land Drain / Stream Crossing Detail - Cross Section Scale 1:50

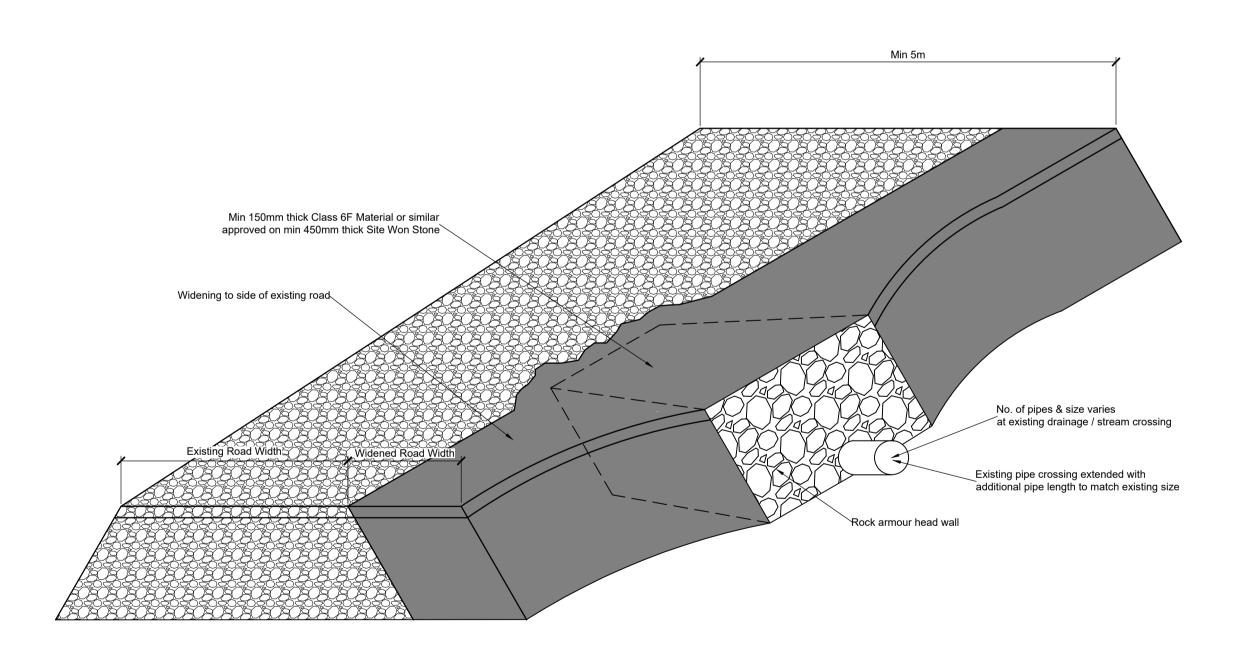

Typical Widening Detail of Existing Land Drain / Stream Crossing Detail Scale 1:50

DO NOT SCALE FROM THIS DRAWING. USE FIGURED DIMENSIONS IN ALL CASES. VERIFY DIMENSIONS ON SITE AND REPORT ANY DISCREPANCIES TO THE DESIGNERS IMMEDIATELY.

THIS DRAWING TO BE READ IN CONJUNCTION WITH THE DESIGNERS SPECIFICATION.

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NOTES:

- ALL DRAWINGS ARE TO BE READ IN CONJUNCTION WITH ALL RELEVANT SPECIFICATIONS, BILLS OF QUANTITIES, ARCHITECTURAL, SERVICES AND ENGINEERING DRAWINGS.
- 2. ALL LEVELS ARE IN METRES RELATED TO ORDNANCE DATUM MALIN HEAD.
- 3. ANY DISCREPANCIES BETWEEN THESE DOCUMENTS SHALL BE BROUGHT TO THE ATTENTION OF THE ENGINEER.
- 4. DRAWINGS ARE NOT TO BE SCALED.
- 5. ALL DIMENSIONS ARE IN MILLIMETRES, UNLESS NOTED OTHERWISE.
- 6. THE FINALISED LAYOUT MAY BE SUBJECT TO MICRO-SITING DUE TO UNFORESEEN GROUND CONDITIONS. THE EXTENT OF FLEXIBILITY WILL BE SITE SPECIFIC AND SHOULD GENERALLY NOT EXTEND BEYOND 20 METRES.

REFERENCE DRAWINGS: DRAWING No.

19876-MWP-00-00-DR-C-5005 Proposed Site Layout - Master Sheet

19876-MWP-00-00-DR-C-5011 Proposed Site Drainage Layout - Master Sheet



DRAWING NUMBER: 19876-MWP-00-00-DR-C-5405

P01